LIGHT FIXTURE (CEILING MOUNTED)

LIGHT FIXTURE (WALL MOUNTED)

RAIN WATER LEADER

LOCATION OF RAIN WATER LEADER TO TERMINATE AT SPLASH PAD IN STC OR STORM WATER DRAIN. RULE OF THUMB: DOWNSPOUT SIZING 1SQIN=100SQFT R.O.T.

CONCRETE FOUNDATION WALL (20MPA) -8" POURED CONCRETE FOUNDATION

WALL -24" WIDE BY 8" DEEP FOOTING 4'-0" BELOW GRADE & RESTING ON UNDISTURBED

SIDING WALL WITH BRICK BASE -BRICK VENEER AT BASE AND BOARD AND BATTEN ON THE UPPER PORTION -1" AIR SPACE FOR BASE VENEER

-AIR BARRIER -1" (R5) RIGID BOARD -7/16" OSB WALL SHEATHING -2-2X6 SPF NO.1 OR 2 WOOD STUD @ 16" o/c W/ R19 BATT INSULATION

-6 mil. VAPOUR BARRIER -1/2" GYPSUM BOARD

(F1)

SLAB ON GRADE -5" THICK CONCR. SLAB (32 MPa) W/ 5-8% AIR ENTRAINMENT -2" (R10) RIGID INSULATION -6" GRAVEL BASE OF 3/4" CLEAR CRUSHED STONE

-OPTIONAL 6"x6" x6/6" WMM REINFORCING WITHIN SLAB

TRUSS ROOF -ASPHALT SHINGLES -ICE & WATER SHIELD @ EAVES & VALLEY -FELT PAPER UNDERLAYMENT -5/8" T&G OSB SHEATHING -PRE-ENG TRUSSES -R60 BATT INSULATION -6 mil POLY VAPOUR BARRIER

STRUCTURAL LEGEND:


-1/2" GYPSUM BOARD

NAILING AS PER OBC REQUIREMENTS UNLESS NOTED OTHERWISE BY **ENGINEER**

CLIMATIC DESIGN:

DESIGN SNOW LOAD 1.5kpa Hourly Wind Pressure 1/10: 0.33kpa Hourly Wind Pressure 1/50: 0.43kpa

L1 2 - 2"x 8" SPF #2 L2 2 - 2"x10" SPF #2 L3 2 - 2"x12" SPF #2

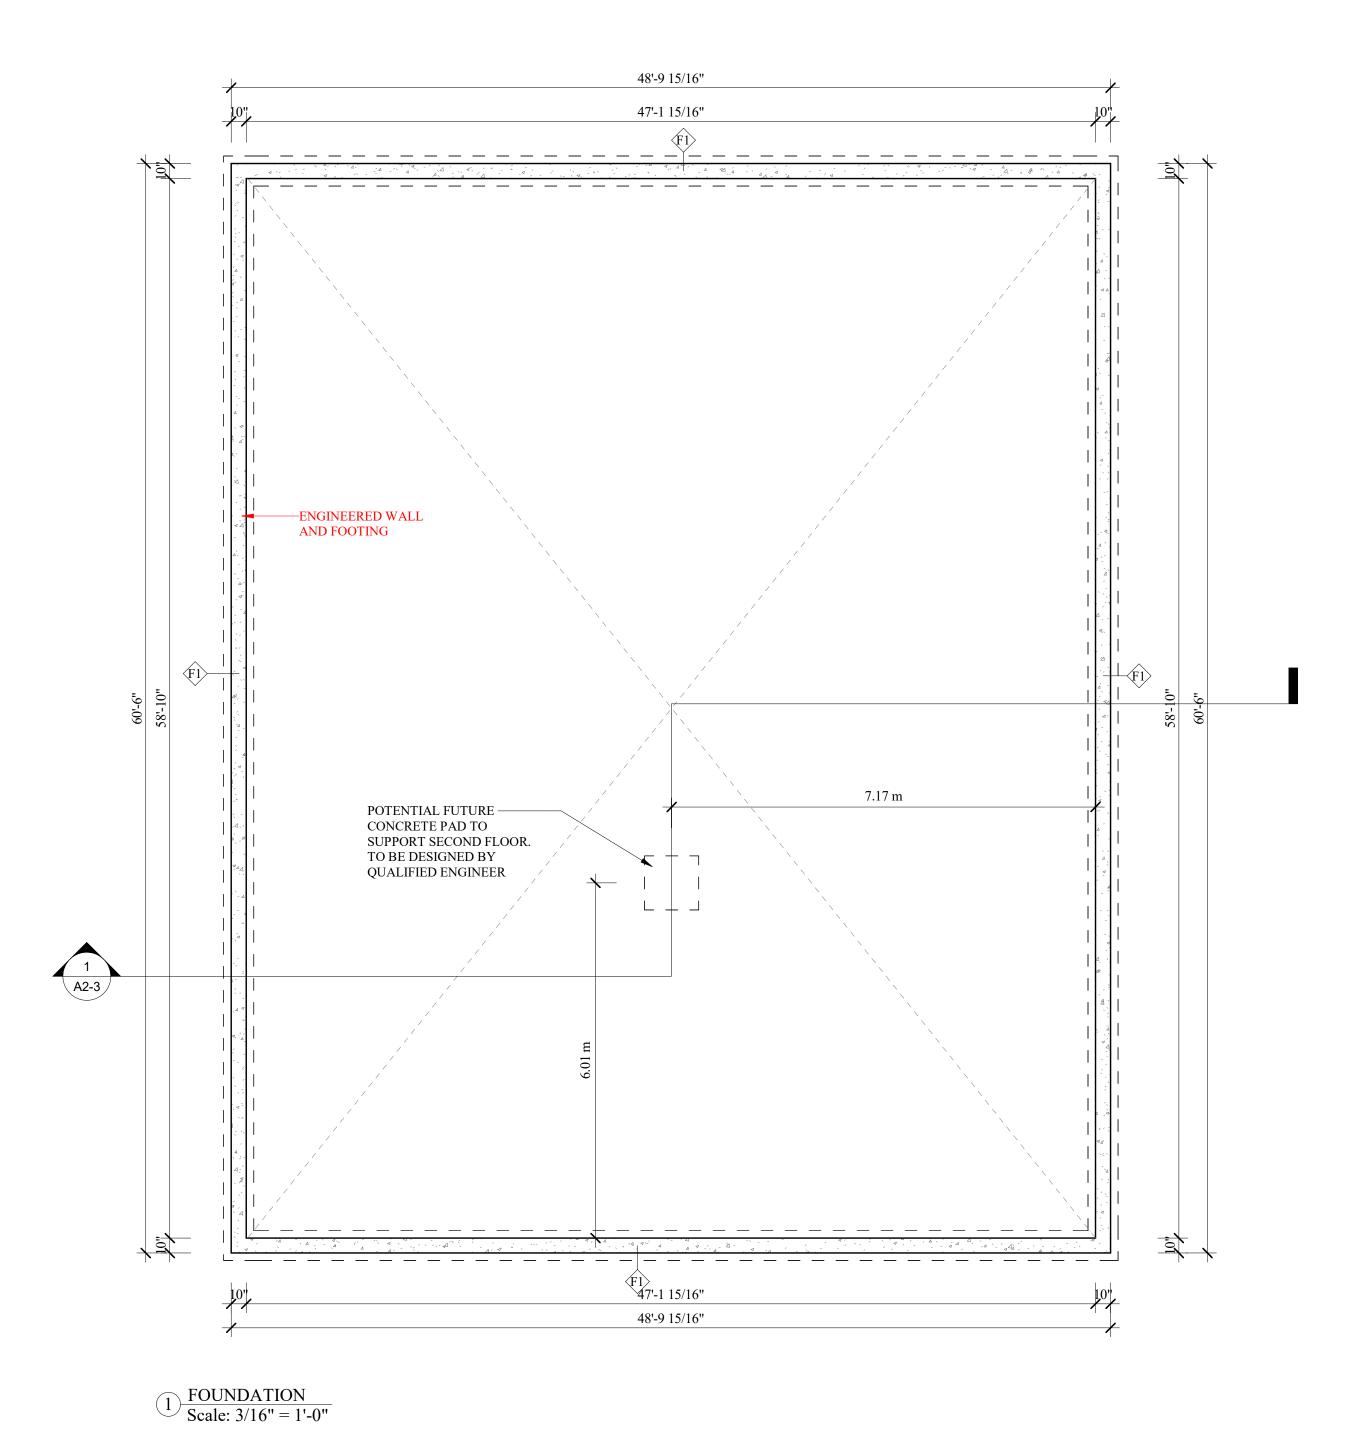



#	Description	Date
1	ISSUED FOR COORDINATION	27MAY2 024
3	ISSUED FOR SEPTIC INSPECTION	08AUG2 024
4	ISSUED FOR MINOR VARIANCE	17JAN2 024

Do not scale drawings. Report any discrepancies to Jordan Station Design Co. Inc. before proceeding. Drawings must be signed by the Licensed Architectural Technologist prior to the use for any building permit applications and / or government approval. Drawings must be signed by the Technologist before drawings are used for any construction. All construction to be in accordance with the current Ontario Building Code & all applicable ON. regulations. All drawings & related documents remain the property of Jordan Station Design Co. Inc., All drawings are protected under copyright and under contract.



The undersigned has reviewed and takes reponsibility for this design, and has the qualifications and meets the requirements set out in the Ontario Building Code to be a designer. QUALIFICATION INFORMATION Required unless design is exempt under 3.2.5.1. of the Ontario Building Code

SIGNATURE

REGISTRATION INFORMATION Required unless design is exempt under 3.2.4.1. of the Ontarior Building Code

NAME

Designed by

SIGNATURE

NEW ACCESSORY BUILDING

874 Line 1 Road, Niagara-on-the-Lake, ON, L0S 1J0

FOUNDATION PLAN

Project number 23086 FEBRUARY 2025 GAC Drawn by


A1-2

Scale As indicated



BCIN

LC

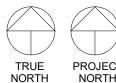

#	Description	Date	
1	ISSUED FOR COORDINATION	27MAY2 024	
3	ISSUED FOR SEPTIC INSPECTION	08AUG2 024	
4	ISSUED FOR MINOR VARIANCE	17JAN2 024	

Do not scale drawings. Report any discrepancies to Jordan Station Design Co. Inc. before proceeding. Drawings must be signed by the Licensed Architectural Technologist prior to the use for any building permit applications and / or government approval. Drawings must be signed by the Technologist before drawings are used for any construction. All construction to be in accordance with the current Ontario Building Code & all applicable ON. regulations. All drawings & related documents remain the property of Jordan Station Design Co. Inc., All drawings are protected under copyright and under contract.



The undersigned has reviewed and takes reponsibility for this design, and has the qualifications and meets the requirements set out in the Ontario Building Code to be a designer.

QUALIFICATION INFORMATION

Required unless design is exempt under 3.2.5.1.

of the Ontario Building Code

SIGNATURE E

REGISTRATION INFORMATION
Required unless design is exempt under 3.2.4.1.
of the Ontarior Building Code

NAME SIGNATURE

NEW ACCESSORY

BUILDING

874 Line 1 Road, Niagara-on-the-Lake, ON, L0S 1J0

GROUND FLOOR PLAN

Project number 23086

Date FEBRUARY 2025

Drawn by GAC

Designed by

Scale

A1-3

As indicated

2025-02-06 4:02:24 PM

BCIN

LC